



**BUS PAVILION ROOF FRAMING PLAN**  
 1  
 38-16 SCALE: 1/2"=1'-0"

FINISHED FLOOR ELEVATION = REFERENCE. ELEVATION SHOWN ON PLAN ARE TOP OF CONCRETE. SEE DRAWING 13-03 FOR REFERENCE ELEVATIONS.  
 SEE GENERAL NOTES ON 38-02 FOR DESIGN SOIL BEARING CAPACITY.  
 SEE SHEETS 38-02 & 38-03 FOR GENERAL NOTES AND ABBREVIATIONS.  
 SEE SHEET 38-17 FOR TYPICAL SECTIONS AND DETAILS.  
 ALL COLUMNS ARE CENTERED ON WIDTH OF FOOTING.  
 COORDINATE WITH ALL DRAWINGS FOR LOCATION OF OPENINGS, CONDUITS, ETC.

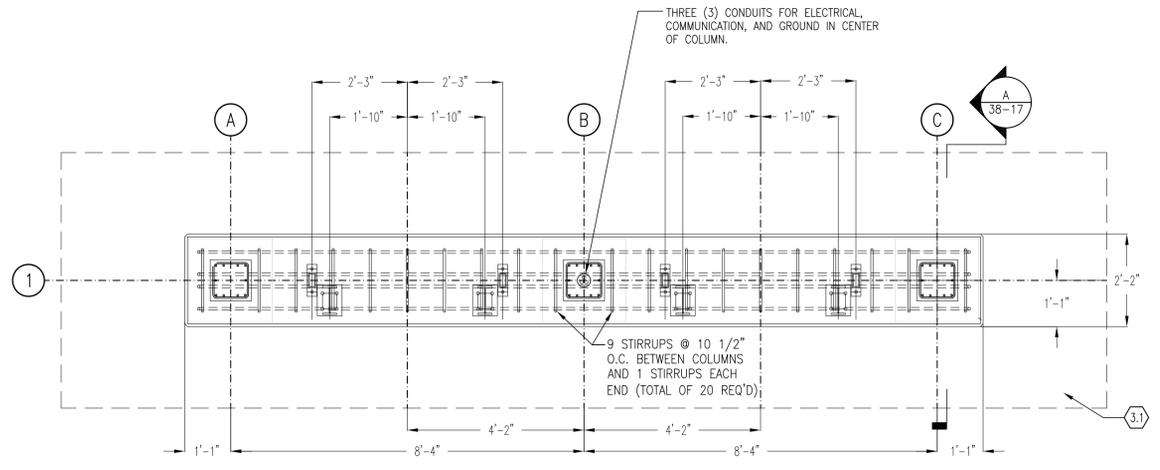

**BUS PAVILION FOUNDATION PLAN**  
 2  
 38-16 SCALE: 1/2"=1'-0"

TOP OF STEEL ELEVATION = VARIES. ELEVATIONS SHOWN ON PLAN ARE TO TOP OF STEEL FROM REFERENCE ELEVATION. SEE DRAWING 13-03 FOR REFERENCE ELEVATIONS.  
 SEE SHEETS 38-02 & 38-03 FOR GENERAL NOTES AND ABBREVIATIONS.  
 SEE SHEET 38-17 FOR TYPICAL SECTIONS AND DETAILS.  
 COORDINATE WITH ALL DRAWINGS FOR LOCATION OF OPENINGS, CONDUITS, ETC.  
 ALL STEEL FRAMING IS CONSIDERED ARCHITECTURALLY EXPOSED STRUCTURAL STEEL. SEE SPECIFICATIONS FOR FABRICATION REQUIREMENTS OF PAVILION FRAMING.  
 VIEW AT TOP OF FOUNDATION.

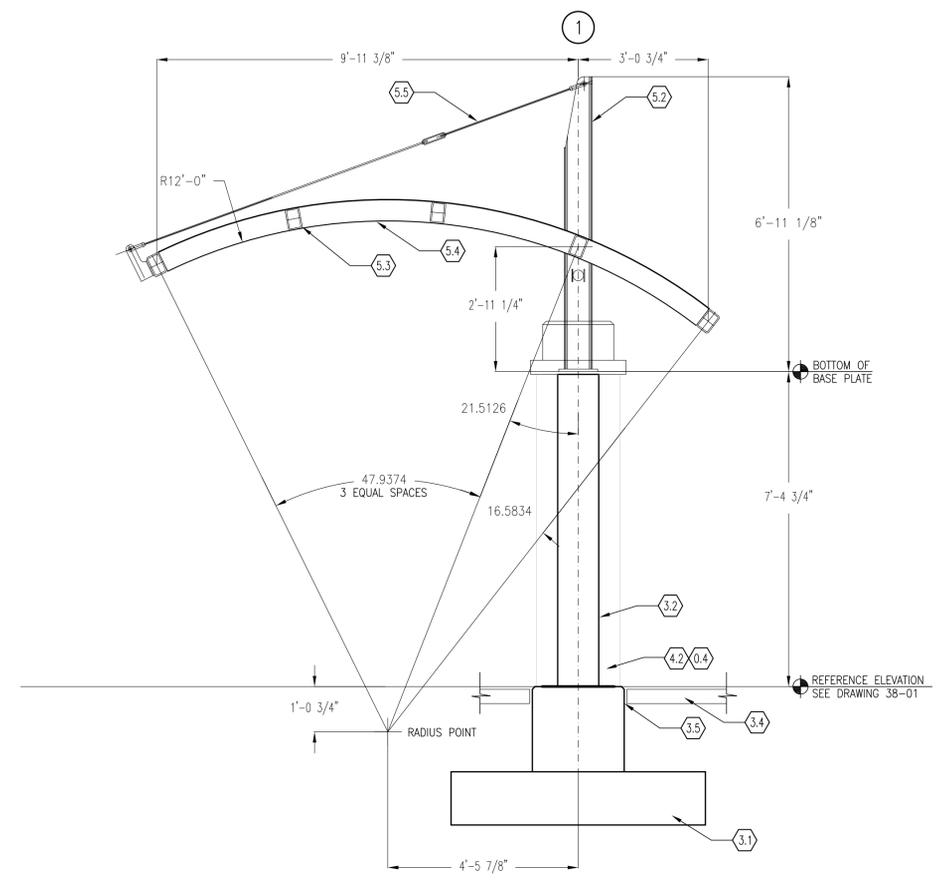


**BUS PAVILION ROOF LAYOUT**  
 3  
 38-16 SCALE: 1/2"=1'-0"

- CODED NOTES**
- 0.1 REFERENCE STRUCTURAL DRAWINGS
  - 0.2 REFERENCE ELECTRICAL DRAWINGS 38-12 AND 38-13
  - 0.3 REFERENCE MECHANICAL DRAWING 38-11
  - 0.4 REFERENCE ARCHITECTURAL DRAWINGS
  - 0.5 REFERENCE CIVIL DRAWINGS
  - 2.1 ORNAMENTAL SECURITY FENCE
  - 3.1 CONCRETE FOUNDATION
  - 3.2 CONCRETE COLUMN
  - 3.3 CONCRETE SLAB
  - 3.4 CONCRETE WALKWAY
  - 3.5 3/4" PREFORMED JOINT FILLER W/3/4" DEEP ELASTOMERIC JOINT FILLER
  - 4.1 8" CONCRETE MASONRY UNITS
  - 4.2 RED BRICK
  - 4.3 NOT USED
  - 4.4 PRECAST CONCRETE COPING
  - 5.1 STEEL TUBE BEAM
  - 5.2 DOUBLE CHANNEL COLUMN
  - 5.3 STEEL TUBE ROOF MEMBER-ROTATED
  - 5.4 STEEL TUBE ROOF MEMBER-CURVED
  - 5.5 3/8" STAINLESS STEEL ROD WITH STAINLESS STEEL CLEVISES AND TURNBUCKLE
  - 5.6 STEEL PLATE
  - 5.7 ANCHOR BOLTS
  - 6.1 3/4" PLYWOOD DEMARC BOARD
  - 7.1 SEALANT W/BACKER ROD
  - 7.2 METAL PANEL SIDING, ONE SIDE, EXTERIOR FACE
  - 8.1 HOLLOW METAL DOOR
  - 8.2 ALUMINUM TUBE SIZE AS NOTED
  - 8.3 3/8" TEMPERED GLASS
  - 8.4 GLAZING W/LAMINATED ROUTE SIGNAGE
  - 8.5 VAULTED TRANSLUCENT MULTIWALL MODULAR POLYCARBONATE STANDING SEAM PANELS
  - 8.6 POLYCARBONATE BATTEN W/END CAPS
  - 8.7 STAINLESS STEEL HOLD-DOWN CLIPS FOR POLYCARBONATE PANELS
  - 8.8 EXTRUDED ALUMINUM CANOPY SILL
  - 8.9 ROLLED ALUMINUM EDGE ANGLE
  - 8.10 MOLDED FIBERGLASS CAP PIECE
  - 10.1 ROUTE SIGNAGE 4'-0" X 4'-0" SURFACE MOUNTED FRAME. GRAPHICS SUPPLIED BY OWNER. MOUNT BOTTOM EDGE 3'-0" ABOVE FLOOR.
  - 10.2 "X-PRESS" SIGNAGE PATTERNED PER "X-PRESS" LOGO AS SHOWN AND COORDINATE COLOR AND GRAPHIC WITH OWNER. TO BE INSTALLED BY GRTA.
  - 10.3 LED DISPLAY (N.I.C.)
  - 11.1 PUBLIC ADDRESS SYSTEM - OWNER FURNISHED, CONTRACTOR INSTALLED
  - 11.2 NEWSPAPER VENDING MACHINE (N.I.C.)
  - 11.3 TICKET VENDING MACHINE (N.I.C.)
  - 13.0 PREFABRICATED PRECAST CONCRETE EQUIPMENT BUILDING WITH INTERIOR INCLUDING INSULATION, DRYWALL, SURFACE-MOUNTED LIGHTS, ELECTRICAL PANELS, CABLE TRAY, OUTLETS AND SWITCHES, HVAC SPLIT SYSTEM, ETC. PROVIDE OPENINGS FOR CONDUITS AS REQUIRED. INSTALL J-BOX FOR FUTURE TICKET VENDING MACHINES.
  - 15.1 HVAC SPLIT SYSTEM
  - 15.2 WATER SERVICE
  - 15.3 HOSE BIB
  - 15.4 THERMOSTAT
  - 15.5 CONDENSATE DRAIN AND SLUMP
  - 16.1 SECURITY/DATA EQUIPMENT RACK (N.I.C.)
  - 16.3 SURFACE MOUNTED LIGHT FIXTURE
  - 16.4 SUSPENDED LIGHT FIXTURE
  - 16.5 CABLE TRAY
  - 16.6 SPEAKER (N.I.C.) W/JUNCTION BOX
  - 16.7 TELECOMMUNICATION CONDUITS
  - 16.8 POWER AND LIGHTING CONDUITS
  - 16.9 ELECTRICAL PANELS/SURGE PROTECTOR
  - 16.10 SIGN LIGHTING. MOUNT ON OUTLET BOX. LIGHT FIXTURE 'SB.' AIM TO ILLUMINATE THE SIGN.

- GENERAL NOTES**
1. ALL STEEL TO BE PAINTED ON BOTH FARE SYSTEM SHELTER AND BUS PAVILION.
  2. STAINLESS STEEL LEANING RAIL SHALL BE BRUSHED FINISH.
  3. ALUMINUM TUBE FRAMING TO BE PAINTED TO MATCH COLOR STRUCTURAL STEEL.

VERSION 1

**URS**  
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REVISIONS	DATE	DESCRIPTION

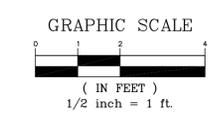STATE OF GEORGIA  
 DEPARTMENT OF TRANSPORTATION  
 OFFICE OF INNOVATIVE PROGRAM DELIVERY  
**BUS PAVILION**  
**FDN AND ROOF FRAMING PLAN**

NEWMAN SR 34 AND HOLLZ PKWY  
 PARK AND RIDE LOT

38-16  
 DRAWING No.